

DECK

BUILDING PERMIT APPLICATION GUIDE

Issued: February 2016 Revised: N/A Page 1 of 2

A building permit is required in the Town of Milton to build a freestanding deck greater than 10 m² (108 ft²) or any deck attached to a building. If you are unfamiliar with of the Town of Milton's permit application process/requirements please consult our website at http://www.milton.ca/en/build/buildingpermits.asp or contact the Planning and Development Department - Building Division at (905) 878-7252 ext. 2397. This guide explains the requirements for submitting a building permit application for a Deck in greater detail.

Zoning Requirements:

Under the Zoning By-law, the location of a deck (and any required stairs) on a property is regulated based on the property zoning and the height of the deck above grade. In addition, the installation of privacy screening on a deck is limited to maximum height of 1.5 m (4'-11") and the combined length of the privacy screen and house wall (adjacent to the deck) cannot exceed 60% of the entire deck perimeter. General Zoning By-law requirements for your property can be obtained by contacting the Zoning Department at (905) 878-7252 ext. 2329 or by checking online at: https://www.milton.ca/en/build/zoning.asp.

Engineering Requirements:

If your subdivision has not been assumed by the Town you will require a developer's clearance letter from the Builder to build your deck. To find out if your subdivision is assumed please contact Engineering Services at (905)878-7252 ext. 2500

Building Permit Application Requirements:

Building permit applications are broken down into 2 major requirements;

- Permit Application Forms
- Construction Drawings

Complete building permit applications are accepted in person on the 2nd floor of Town Hall at 150 Mary St. The cost of the building permit and required permit application forms can be found on the Town's website at: http://www.milton.ca/en/build/buildingpermits.asp. Building permit fees are payable by cash, cheque or debit at the time of application. Building permit fees include the review of drawings and all required inspections.

Permit Application Forms

1) Application for a Permit to Construct or Demolish

All sections of the form must be completed, including the full legal description (which can be found on your deed, tax assessment, survey, or is available from the public computer kiosk located on the main floor of Town Hall next to the Reception area).

2) Schedule 1 Designer Form

This form is required when someone other than an Architect or Licensed Professional Engineer is taking responsibility for the design of the Deck. This person would be either:

- o the homeowner taking legal responsibility for the design, provided they understand and are willing to take responsibility for the applicable requirements of the Ontario Building Code, or
- o a registered designer with a Building Code Identification Number (BCIN) qualified in House or Small Buildings



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Construction Drawings

All drawings must be submitted in black and white, drawn to an appropriate scale (min 3/16" = 1' or metric equivalent), and clearly legible. Drawings in pencil shall be photocopied prior to submission, with the density adjusted so that all information is clear and legible. Every page of the drawings shall include the project address and the following designer information:

Homeowner design	- printed name of homeowner, signature and date
Qualified BCIN design	- printed name, individual/firm (if applicable) BCIN numbers, signature and date
Architect or Professionally	- Architect's or Professional Engineer's seal with a signature and date
Engineered design	

The following construction drawings are required for a Deck:

- 1) Site Plan (Sample D-1)
- 2) Deck Structural/Floor Layout (Sample D-2)
- 3) Deck Section & Details (Sample D-3)

Refer to the enclosed sample drawings for specific drawing requirements, including the number of copies of each drawing required. Sample D-4 includes acceptable deck footings options as well as tables for sizing footings, joists and beams. Where steel helical pier/piles are used additional drawings and documentation is required (see Sample D-4). Deck design printouts from large box stores are not acceptable construction drawings, and must be redrawn to meet the requirements shown in the sample deck construction drawings.

If any proposed guard components (post, top/bottom rail, baluster, etc.) are not wood, the drawings must include connection/construction details stamped by a Professional Engineer Licensed to practice in Ontario. These details are typically available from supplier or manufacturer's websites. In addition, any privacy screen (wood or other material) that also serves as guard must be designed by a Professional Engineer.

Inspection Requirements:

Typical Deck inspections can include (depending on the scope of work):

- Footing
- Framing
- Final Building


Inspections are booked by calling the Building Division at (905) 878-7252 ext. 2396 or by emailing in the Inspection Request Form available on our website at http://www.milton.ca/en/build/buildinginspections.asp.





PROJECT

ECT TRUE

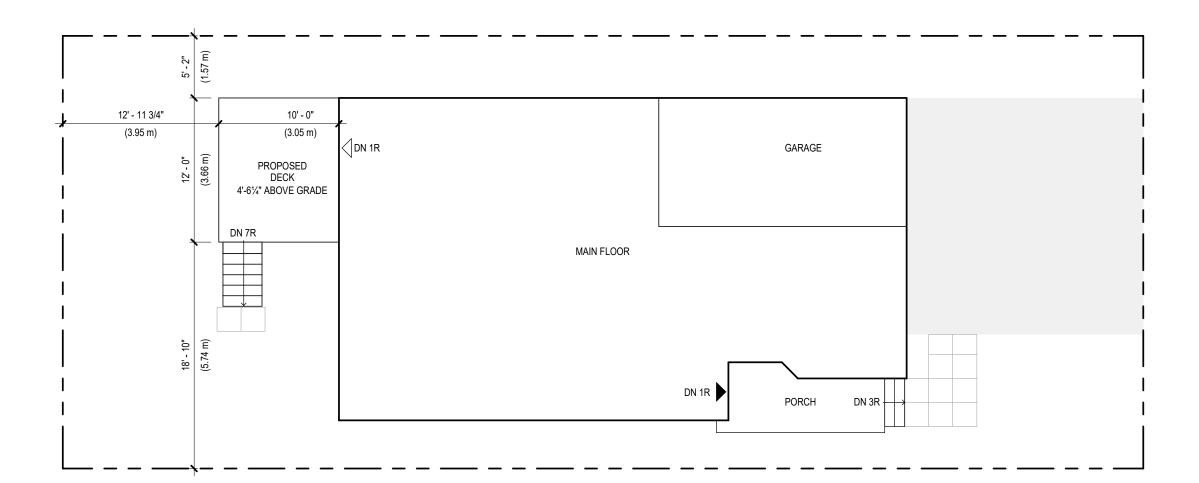

1 SITE PLAN
D-1 1/8" = 1'-0"

NOTE

THE ITEMS ON THIS DRAWING, INCLUDING DIMENSIONS, ARE BEING PROVIDED TO SHOW THE DRAWING REQUIREMENTS FOR THE SITE PLAN ONLY. THEY DO NOT NECESSARILY REFLECT THE ACTUAL TOWN OF MILTON ZONING BY-LAW REQUIREMENTS FOR YOUR SPECIFIC PROPERTY. FOR SPECIFIC ZONING BY-LAW REQUIREMENTS FOR YOUR PROJECT CONTACT THE TOWN OF MILTON ZONING DEPARTMENT DIRECTLY AT (905)878-7252 EXT. 2329

LEGEND

PROPERTY LINE

24" x 24" CONCRETE PATIO STONE WALKWAY

SAMPLE DRAWINGS



TOWN OF MILTON BUILDING DIVISION

150 MARY ST MILTON ON L9T 6Z5 (905) 878-7253 EXT. 2397

BUILDING PERMIT APPLICATION GUIDE: DECK

DRAWING NAME:

SITE PLAN

NUMBER OF COPIES REQUIRED:
2 (5 WHEN SUBDIVISION IS
NOT ASSUMED)

DRAWING <u>MUST</u> INCLUDE/SHOW (IF APPLICABLE): <u>STRUCTURES:</u>

- HOUSE (INCLUDING PORCH & EXTERIOR STAIRS)
- ACCESSORY BUILDINGS (SHED/GARAGE) - DECK
- POOL
- HARD LANDSCAPED SURFACES:
- DRIVEWAY
- WALKWAYS/PATIOS

SETBACKS:

- DECK TO PROPERTY LINES
- REAR WALL OF HOUSE TO REAR PROPERTY LINE

DIMENSIONS:

- DECF

GENERAL/OTHER NOTES:

- DECK HEIGHT ABOVE GRADE (AT LOWEST POINT OF GRADE)
- LEGEND OF LINE TYPES, SYMBLOLS, AND HATCHING USED

DESIGNER: JOE SMITH


PROJECT 123 MAIN STREET ADDRESS: MILTON, ONTARIO


SHEET SIZE: 11" X 17"


SHEET NO.

DATE: JANUARY 2016 SCALE: AS INDICATED


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3 TYPICAL GUARD DETAIL
D-3 3/4" = 1'-0"

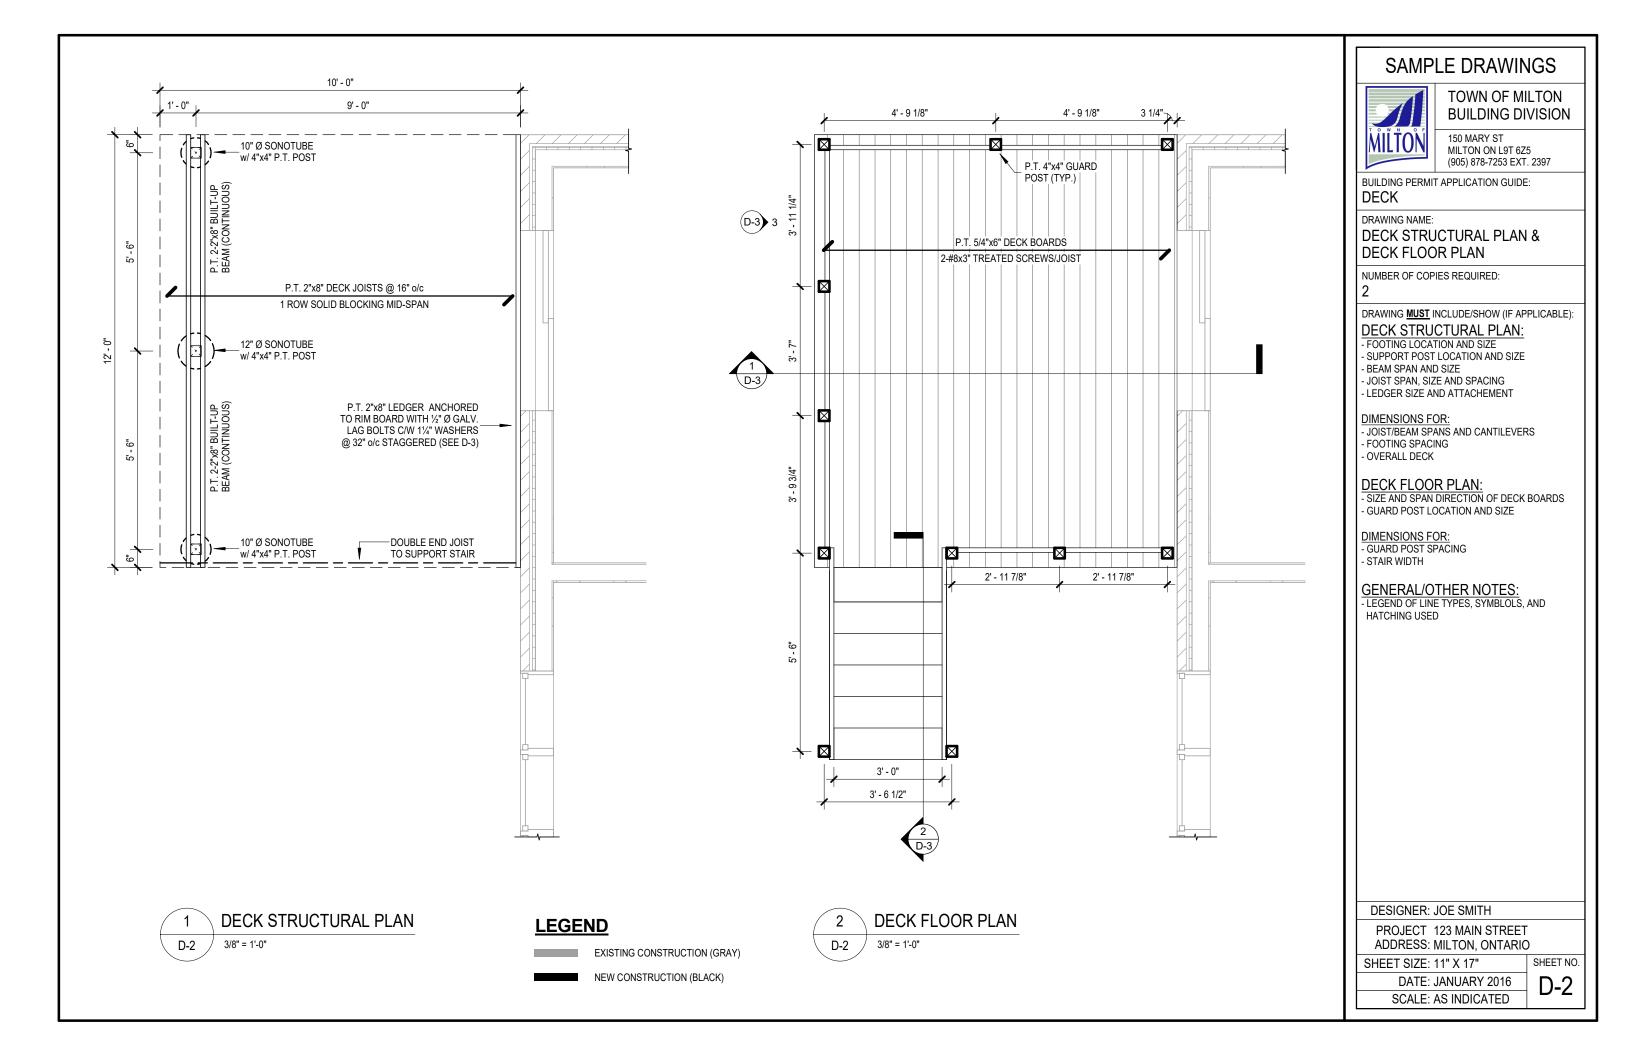

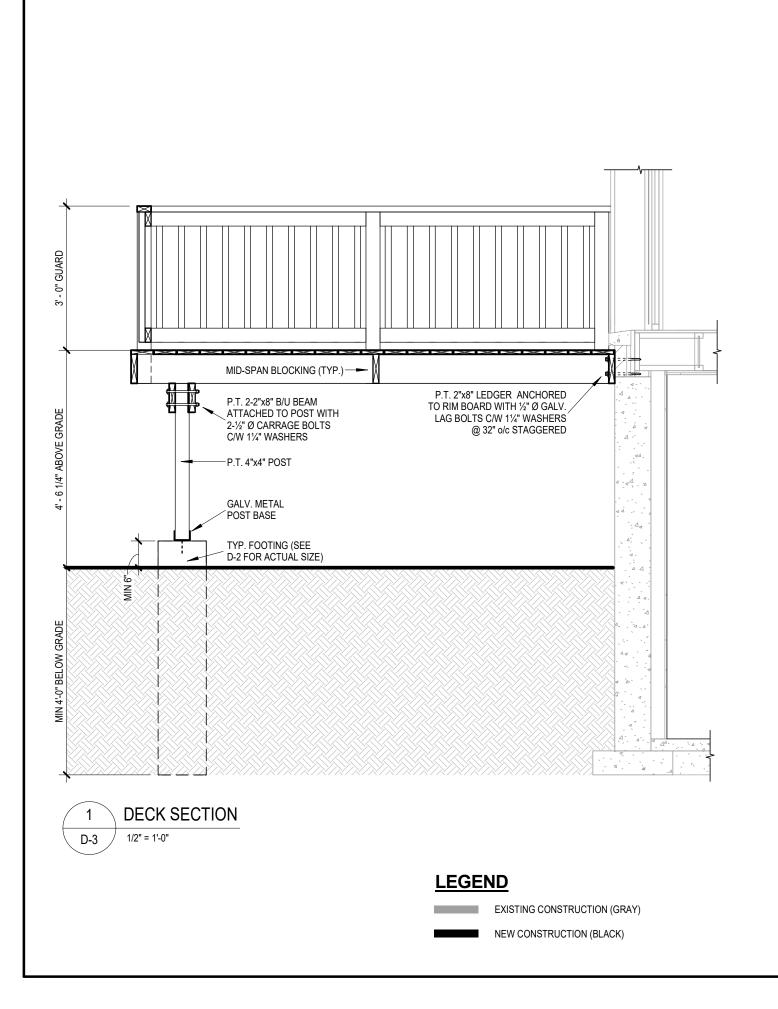2 STAIR SECTION
D-3 1/2" = 1'-0"

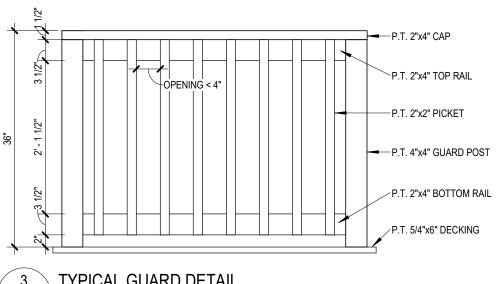SAMPLE DRAWINGS

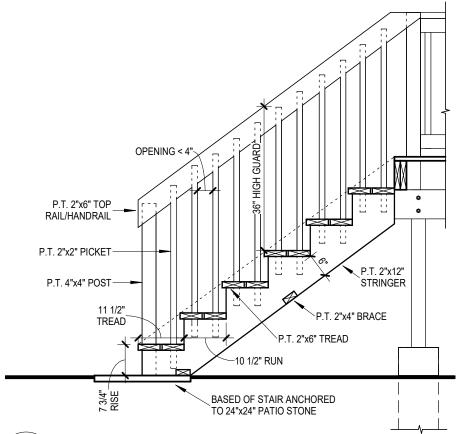

TOWN OF MILTON BUILDING DIVISION

150 MARY ST MILTON ON L9T 6Z5 (905) 878-7253 EXT. 2397

BUILDING PERMIT APPLICATION GUIDE: DECK

DRAWING NAME:

DECK SECTIONS & DETAILS

NUMBER OF COPIES REQUIRED:

DRAWING MUST INCLUDE/SHOW (IF APPLICABLE):

DECK SECTION:

- FOOTING
- SUPPORT POST AND METAL POST BASE
- BEAM SIZE AND ATTACHENT TO POST
- LEDGER SIZE AND ATTACHMENT TO HOUSE

DIMENSIONS FOR:

- HEIGHT OF DECK ABOVE GRADE (AT LOWEST POINT OF GRADE)
- OVERALL GUARD HEIGHT
- FOOTING DEPTH BELOW GRADE

TYPICAL GUARD DETAIL:

GUARDS ARE REQUIRED WHEN THE FINISHED DECK FLOOR IS 24" OR MORE ABOVE GRADE

- SIZE AND LOCATION OF POSTS, BOTTOM/TOP RAIL. TOP CAP AND PICKETS

NOTE: AN ENGINEERED STAMPED DETAIL IS REQUIRED FOR ANY GUARD SYSTEM:

- THAT INCORPORATES ANY
- COMPONENET THAT IS NOT WOOD, OR
 IS BUILT HIGHER THAN 3'-6" (SUCH AS A
 PRIVACY SCREEN SERVING AS A GUARD)

DIMENSIONS FOR:

- OVERALL GUARD HEIGHT
- THE TOP AND BOTTOM OF ALL HORIZONTAL COMPONENTS OF THE GUARD (BOTTOM/TOP RAIL, CAP, ETC.)
- SPACING BETWEEN PICKETS

STAIR SECTION:

- SIZE OF STRINGER, TREADS AND RISERS
- GUARD POST LOCATION AND SIZE

DIMENSIONS FOR:

- OVERALL GUARD HEIGHT
- STAIR RISE, RUN AND TREAD DEPTH
- EFFECTIVE DEPTH OF STAIR STRINGER

GENERAL/OTHER NOTES:

- LEGEND OF LINE TYPES, SYMBLOLS, AND HATCHING USED

DESIGNER: JOE SMITH


PROJECT 123 MAIN STREET ADDRESS: MILTON, ONTARIO

DATE: JANUARY 2016

SHEET SIZE: 11" X 17"

SHEET NO.

SCALE: AS INDICATED

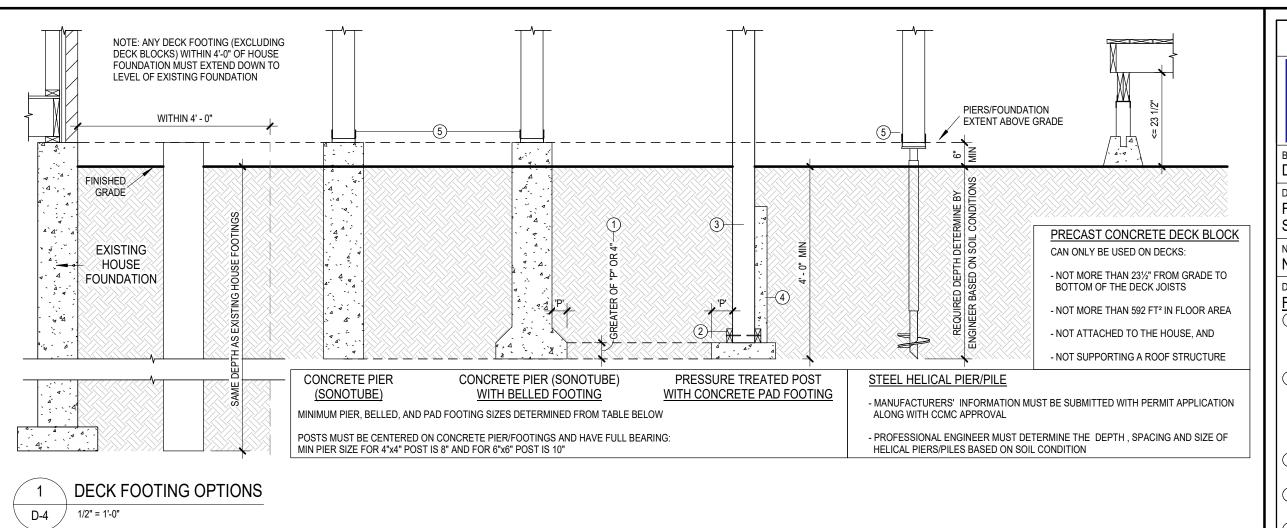

REQUIRED DECK FOOTINGS CAPACITY

FOOTING LOAD = SUPPORTED BEAM LENGTH x SUPPORTED JOIST LENGTH x 40 LBS/FT2 (DECK LOAD)

USE FOOTING/PIER SIZING TABLE BELOW TO DETERMINE MINIMUM FOOTING SIZE BASED ON FOOTING LOAD

EXAMPLE (MIDDLE FOOTING): SUPPORTED BEAM LENGTH = 8 FT

SUPPORTED JOIST LENGTH = 7 FT FOOTING LOAD = 8 FT x 7 FT x 40 LBS/FT² = 2240 LBS

MIDDLE FOOTING WOULD REQUIRE MIN 16" ROUND FOOTING OR 14" SQUARE FOOTING


FOOTING/PIER SIZING TABLE

MINIMUM	MAX. FOOTING CAPACITY			
FOOTING SIZE	ROUND (DIA)	SQUARE		
8"	729 LBS	928 LBS		
10"	1139 LBS	1450 LBS		
12"	1640 LBS	2089 LBS		
14"	2233 LBS	2843 LBS		
16"	2916 LBS	3713 LBS		
18"	3691 LBS	4699 LBS		

NOTE: MAX FOOTING CAPACITY BASED ON A SOIL BEARING CAPACITY OF 2000 LBS/FT


FLOOR JOIST SPAN TABLE

JOIST SIZE	SPACING (o/c)	MAX. JOIST SPAN	MAX. JOIST CANTILEVER		
2"x6"	12"	10'-4"	NOT		
	16"	9'-4"	NOT PERMITTED		
	24"	8'-2"	I ERWITTED		
2"x8"	12"	12'-5"	LESSER OF 16"		
	16"	11'-9"	OR 1/7 OF TOTAL		
	24"	10'-9"	JOIST LENGTH		
2"x10"	12"	14'-6"			
	16"	13'-9"			
	24"	12'-10"	LESSER OF 24" OR 1/7 OF TOTAL		
2"x12"	12"	16'-4"	JOIST LENGTH		
	16"	15'-5"	33.3. 22.10111		
	24"	14'-6"			

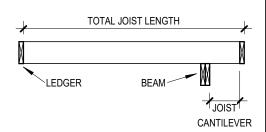

BEAM SPAN TABLE

SUPPORTED JOIST LENGTH	MAX. 2-PLY BEAM SPAN			MAX. 3-PLY BEAM SPAN				
	2"x6"	2"x8"	2"x10"	2"x12"	2"x6"	2"x8"	2"x10"	2"x12"
4'-0"	8'-0"	10'-4"	12'-7"	14'-7"	9'-7"	12'-7"	16'-1"	19'-7"
6'-0"	6'-10"	8'-4"	10'-4"	11'-9"	8'-4"	11'-0"	14'-1"	17'-1"
8'-0"	5'-11"	7'-2"	8'-10"	10'-3"	7'-7"	10'-0"	11'-10"	14'-1"
10'-0"	5'-3"	6'-5"	7'-10"	9'-2"	7'-1"	9'-4"	10'-10"	12'-7"
12'-0"	4'-10"	5'-11"	7'-2"	8'-4"	6'-8"	8'-7"	9'-11"	11'-6"
14'-0"	4'-6"	5'-5"	6'-8"	7'-9"	6'-4"	7'-11"	9'-2"	10'-8"

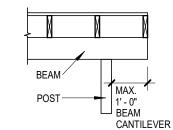

STRUCTURAL SIZING TABLES

N.T.S. D-4

SAMPLE DRAWINGS



TOWN OF MILTON **BUILDING DIVISION**

150 MARY ST MILTON ON L9T 6Z5 (905) 878-7253 EXT. 2397

BUILDING PERMIT APPLICATION GUIDE: DECK

DRAWING NAME:

FOOTING OPTIONS & STRUCTURAL SIZING INFO.

NUMBER OF COPIES REQUIRED:

N/A

DRAWING MUST INCLUDE/SHOW (IF APPLICABLE): FOOTING NOTES:

- 1) MINIMUM DEPTH OF BELLED/PAD FOOTING IS THE GREATER OF 4" OR THE PROJECTION "P" OF THE BELLED/PAD FOOTING BEYOND THE
- (2) POST BEARING ON PAD FOOTING REQUIRES 2-2"x4" P.T. CLEATS FASTENED TO OPPOSITE SIDES OF THE POST WITH MIN. 3-31/2" GALVANIZED NAILS TO RESIST UPLIFT. CLEATS SHALL EXTEND MIN 2" PAST EITHER SIDE OF POST
- 3 BURIED PRESSURE TREATED POST MUST BE RATED FOR GROUND CONTACT
- (4) OPTIONAL CONCRETE BACKFILL AROUND
- 5 POST SADDLE ANCHORED TO CONCRETE/STEEL HELICAL PIER/PILE.

FOOTING SIZING NOTES:

DECKS FOOTING SUPPORTING ROOF OR OTHER STRUCTURES (HOT TUB, ETC.) MUST INCLUDE THE WEIGHT OF THESE STRUCTURES IN THE FOOTING DESIGN

ROOF LOADING CAN BE TAKEN AT 30 LBS/FT2 HOT TUB LOADING WILL DEPEND IN SIZE AND DEPTH OF WATER (INCLUDE HOT TUB SPECIFICATIONS WITH PERMIT APPLICATION)

JOIST/BEAM SPAN NOTES:

6) WHERE A DECK IS 2'-0" OR MORE ABOVE GRADE AND REQUIRES A GUARD OR WHERE A GUARD IS PROVIDED (BUT NOT REQUIRED) ON A LOWER DECK, THE MINIMUM FLOOR JOIST SIZE IS 2"x8"

DESIGNER: JOE SMITH

PROJECT 123 MAIN STREET ADDRESS: MILTON, ONTARIO

SHEET SIZE: 11" X 17"

DATE: JANUARY 2016

SCALE: AS INDICATED

SHEET NO

D-4

BEAM CANT.

EQUAL

CALCULATING FOOTING SUPPORTING AREA AND MINIMUM FOOTING SIZE N.T.S.

BEAM SPAN

BEAM CANT.

SUPPORTED BEAM LENGTH = 8 FT

EQUAL

BEAM SPAN