

# New Decks and Porches - Building Permit Application Requirements

A building permit is required for any deck/porch that is 600mm (23 5/8 inches) or greater above grade OR any deck that is 18.6 m2 ( 200 sqft) or greater in building area.

The following information is required with all deck building permit applications:

# **Designer Requirements**

All drawings submitted for building-permit application are required to be prepared by the listed homeowner or by a qualified designer, architect or professional engineer or a combination thereof. Some drawings must be designed by a professional engineer when the design falls under the scope of Parts 4 & 9, Division B of the 2012 Ontario Building Code.

The Building Code requires qualified and registered designers who review and take responsibility for design activities to include the following information on any documents submitted to a chief building official:

- The name and building code identification number (BCIN) of the registered firm.
- A statement that the qualified person has reviewed and taken responsibility for the design activities.
- The name and BCIN of the qualified person.
- The signature of the qualified person.

# Drawing Requirements (Please provide 2 sets of all required drawings)

- 1) Property survey or site plan of your lot indicating the location of the proposed deck with dimension to property lines
- 2) Deck construction drawings
  - a. Plan view showing posts, floor joists, beams and stairs
  - b. Side elevation of deck showing height of deck, guard details and footings
  - c. Cross section view detailing proposed construction.

All drawings shall be fully dimensioned, drawn at minimum scale of 1:75 or 3/16"= 1'-0"

NOTE: Wood guards/railings are permitted under the Ontario Building Code. Should your deck design specify any guard/railing other than a wood, please submit a copy of the Pre-Engineered guard/railing details with your building permit application. Typically you can receive this package of details from the supplier.

#### **Additional Information Required for Application**

- Application for a Permit to Construct or Demolish
- Schedule 1 Designer Information Form
- Approval from Toronto and Region Conservation Authority (if applicable)



- Approval from City of Vaughan Heritage Department (if applicable)
- Any other documents that pertain to your project

#### **Fees**

Building permit fees are payable at the time of application and are as follows:

Building Permit Fee \$103.00 flat fee

#### **Permit Processing and Turn-Around Time**

Once a complete permit application is made it will be reviewed by a Zoning Examiner and an Architectural Plans Examiner. The applicant will be advised directly by the plans examiners of any examination deficiencies as the permit application makes its way through the various stages of review.

Building Permit review times are dependent upon permit volumes. An application is considered "complete" if all required forms, documents and applicable information have been submitted and all permit fees and have been paid. If an applications is "complete", the City of Vaughan endeavours to issue the permit or advise applicants of all application examination deficiencies within 10 business days from the date of the application.

Applications that do not have all the required forms, documents and applicable information are considered "incomplete" and are not subject to timeline specified above.

### Where to Apply

To apply for a building permit please bring all required documents to the Building Standards Department on the 1st floor at City Hall. City Hall is located at 2141 Major Mackenzie Drive, Vaughan, Ontario.

#### **Office Hours**

Monday to Friday 8:30am – 4:30pm

#### Questions?

Phone: 905-832-8510



# Application for a Permit to Construct or Demolish This form is authorized under subsection 8(1.1) of the Building Code Act, 1992

	For use by	-	al Authority					
Application number:		Permit	number (if different):					
Date received:		Roll nu	mber:					
Application submitted to:		OF VAU						
, , , , , , , , , , , , , , , , , , ,	ity, upper-tier mun	icipality, bo	pard of health or conservatio	n author	rity)			
A. Project information  Building number, street name				Unit	number		Lot/con.	
	Deetel eede		Diam mumah ay/ath ay daga					
Municipality City of Vaughan	Postal code		Plan number/other des	cription	! 			
Project value est. \$			Area of work (m <sup>2</sup> )					
B. Purpose of application  ☐ New construction ☐ Addition is		∧l±a	ation/rangin	Demolit	··-		Conditiona	.1
Proposed use of building	uilding	□ Alter ent use o		Demoiii	uon		Permit	,I
	Cuin	ent use o	Dullaling					
Description of proposed work								
C. Applicant Applicant is:	Owner o	or I	☐ Authorized agent of	fowne	r			
Last name	First name		Corporation or partners	ship				
Street address	1			Unit r	number	L	ot/con.	
Municipality	Postal code		Province	E-ma	iil			
Telephone number	Fax ( )		1	Cell r	number )			
D. Owner (if different from applicant)								
Last name	First name		Corporation or partners	ship				
Street address	1		1	Unit r	number	L	ot/con.	
Municipality	Postal code		Province	E-ma	iil			
Telephone number	Fax ( )		<u> </u>	Cell r	number )			
E. Builder (optional)					,			
Last name	First name		Corporation or partners	ship (if a	applicable)	)		
Street address			1	Unit	number	L	ot/con.	
Municipality	Postal code		Province	E-ma	nil			
Telephone number	Fax			Cell r	number			
F. Tarion Warranty Corporation (Ontari	o New Home	Warrant	ty Program)	1 \	,			
i. Is proposed construction for a new hor Plan Act? If no, go to section G.	ne as defined in	the Onta	rio New Home Warrantie	S		Yes		No
ii. Is registration required under the Onta		Varranties	s Plan Act?			Yes		No
iii. If yes to (ii) provide registration numbe	r(s):							
G. Required Schedules  i) Attach Schedule 1 for each individual who re	views and takes	responsi	bility for design activities					
ii) Attach Schedule 2 where application is to co	nstruct on-site, i	install or						
H. Completeness and compliance with	• •		(1) (5)		T			
i) This application meets all the requirements of clauses 1.3.1.3 (5) (a) to (d) of Division C of the Building Code (the application is made in the correct form and by the owner or authorized agent, all applicable fields have been completed on the application and required schedules, and all required schedules are submitted).						No		
Payment has been made of all fees that are regulation made under clause 7(1)(c) of the application is made.	Building Code A	lct, 1992,	to be paid when the			Yes		No
ii) This application is accompanied by the plans resolution or regulation made under clause 7				y-law, 		Yes		No
iii) This application is accompanied by the inform law, resolution or regulation made under class the chief building official to determine whether contravene any applicable law.	use 7(1)(b) of the er the proposed	e <i>Building</i> building,	g Code Act, 1992 which e construction or demolition	nable		Yes		No
iv) The proposed building, construction or demo	lition will not co	ntravene	any applicable law.			Yes		No

	(print name)					declare that:
at	the information contained in thi ttached documentation is true the owner is a corporation or p	to the best of my kno	wledge.			
	Date	Signature of appl	icant			
in the administration in the administration Building Official building official	mation contained in this form and s ration and enforcement of the <i>Buill</i> al of the municipality or upper-tier n in relation to sewage systems or p irector, Building and Development	ding Code Act, 1992. Q nunicipality to which this plumbing for an upper-ti	uestions about the co s application is being r er municipality, board	llection of personance made, or, b) the l of health or co	onal information e inspector havin onservation author	may be addressed to: a) the Ch of the powers and duties of a ch ority to whom this application is
	Private Pro	operty Tree I	Protection E	By-Law 1	185-2007	
subject to a Enquiries or o	g is required be completed for Site Plan Agreement), and questions respecting the City's operations Centre 2800 Ruther	all Additions, Ac	cessory Bldgs, I be directed to Pa	Decks, and rks and Fores	<b>Demolition P</b> stry Operations	<u>Permit</u> applications.  Department located
	onstruction activity associameter or greater when n					
	any existing tree(s) in acc		_	_ \ <u>\</u>		□ No
I	(print name)					_certify that:
	mation contained within the above thority to bind the corporation or page					
		Offic	e Use Only			
Issued Da	te:					
Elevation No.	·	Model No	R	Repeat Permit	No	
Number of Re	esidential Units Created	Num	nber of Residential	Units Lost (D	emo Only)	
Permit Type	Area Code	Building Type	Work Propos	sed Occ.	. Class	Plumbing Work Included
Gross Floor A	rea (m²)	TACBOC \$/sqm.		Calcu	ulated Estimate	☐ Yes ☐ No ed Value of Construction (\$)
Building Perm	nit Payments:				Bui	ilding Permit Fees
Permit Fee Mu	ultiplier:				Total Due:	\$
Date:	Payment Type:	F	Receipt:		Deposit:	\$
	Payment Type:				Balance:	\$
		!\	τουσίρι			
onditional Pe	ermit Fee Payment:				Amount Pai	•
Date:	Payment T	ype: <u>011</u> R	Receipt:		Total Fee Pa	aid \$
Plumbing Pay	yments:				Plui	mbing Permit Fees
Permit Fee Mu	ultiplier:				Total Due:	\$
Date:	Payment Type:0	) <u>24                                    </u>	Receipt:		Deposit:	\$
Date:	Payment Type: :	<u>024</u> [	Receipt:		Balance:	\$
Septic Fee Pa	yments:				Se	eptic Permit Fees
Date:	Payment Type:0	) <u>24                                    </u>	Receipt:		Total Due	\$
	Payment Type: :	024 R	Receipt:			
)ate:			''. D '	o □ No S	Security Deno	osit Tyne:
Security Dep	oosit Required:   Yes   N	•				• •
Security Dep	reement: ☐ Yes ☐ No A	dd. Security Dep.				
Security Dep ndustrial Agi Developmen Bill 124 – Re	•	dd. Security Dep.	Amount: \$			• •

# **Schedule 1: Designer Information**

Use one form for each individual who reviews and takes responsibility for design activities with respect to the project.


A. Project Information		<u> </u>		
Building number, street name			Unit no.	Lot/con.
Municipality	Postal code	Plan number/ other descrip	tion	
B. Individual who reviews and takes	responsibili	ty for design activities		
Name	•	Firm		
Street address			Unit no.	Lot/con.
Municipality	Postal code	Province	E-mail	
Telephone number ( )	Fax number ( )		Cell number	
C. Design activities undertaken by i Division C]	ndividual ide	ntified in Section B. [Bu	ilding Code Tabl	e 3.5.2.1. of
☐ House ☐ Small Buildings ☐ Large Buildings ☐ Complex Buildings ☐ Description of designer's work		g Services on, Lighting and Power		
Description of designer's work				
D. Declaration of Designer				
I(print name	e)	de	eclare that (choose	one as appropriate):
□ I review and take responsibility C, of the Building Code. I am of Individual BCIN:  Firm BCIN: □ I review and take responsibility	qualified, and th	e firm is registered, in the app	oropriate classes/ca	ategories.
under subsection 3.2.5.of Divi	sion C, of the B	uilding Code.		, ,
<ul> <li>The design work is exempt fro Basis for exemption from</li> </ul>	-	on and qualification requirement I qualification:	-	
I certify that:  1. The information contained in this s 2. I have submitted this application w		ge and consent of the firm.		
Date		Signature of Designer		

### NOTE:

- 1. For the purposes of this form, "individual" means the "person" referred to in Clause 3.2.4.7(1) (c).of Division C, Article 3.2.5.1. of Division C, and all other persons who are exempt from qualification under Subsections 3.2.4. and 3.2.5. of Division C.
- Schedule 1 is not required to be completed by a holder of a license, temporary license, or a certificate of practice, issued by the Ontario
  Association of Architects. Schedule 1 is also not required to be completed by a holder of a license to practice, a limited license to practice, or a
  certificate of authorization, issued by the Association of Professional Engineers of Ontario.


# **Schedule 2: Sewage System Installer Information**


A. Project Information							
Building number, street name			Unit number	Lot/con.			
Municipality	Postal code	Plan number/ other desc	ription				
B. Sewage system installer							
Is the installer of the sewage system enga emptying sewage systems, in accordance	aged in the busine with Building C	ness of constructing on-site, in ode Article 3.3.1.1, Division (	installing, repairing, s C?	servicing, cleaning or			
☐ Yes (Continue to Section C)	□ No (	(Continue to Section E)		nknown at time of on (Continue to Section E)			
C. Registered installer informatio	n (where ansv	ver to B is "Yes")					
Name			BCIN				
Street address			Unit number	Lot/con.			
Municipality	Postal code	Province	E-mail				
Telephone number ( )	Fax ( )		Cell number ( )				
D. Qualified supervisor information	on (where ans	wer to section B is "Yes	5")				
Name of qualified supervisor(s)		Building Code Identification	n Number (BCIN)				
E Declaration of Applicants							
E. Declaration of Applicant:							
1				declare that:			
(print name)							
<ul> <li>I am the applicant for the permit t submit a new Schedule 2 prior to</li> </ul>			er is unknown at time	e of application, I shall			
<u>OR</u>							
□ I am the holder of the permit to c known.	construct the sew	age system, and am submitt	ting a new Schedule	2, now that the installer is			
I certify that:							
	The information contained in this schedule is true to the best of my knowledge.						
Date		Signature of applicant					

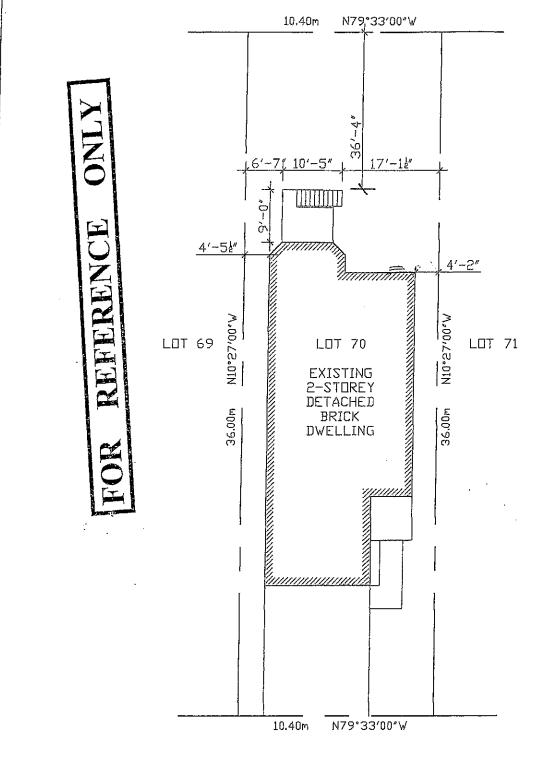


SITE PLAN

GLIENT:	SCALE: 1/16" = 1'-0"	PROJECT NO.
PROJECT: DECK ·	DATE: APRIL 2006	DWG. NO.
DRAWING TITLE: SITE PLAN	DRAWN BY:	

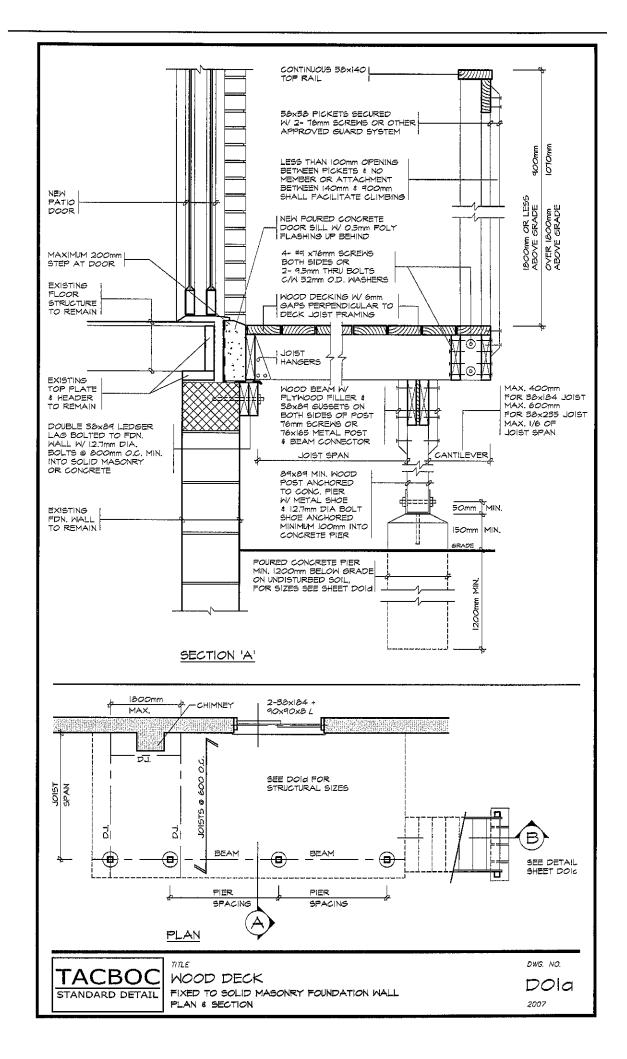

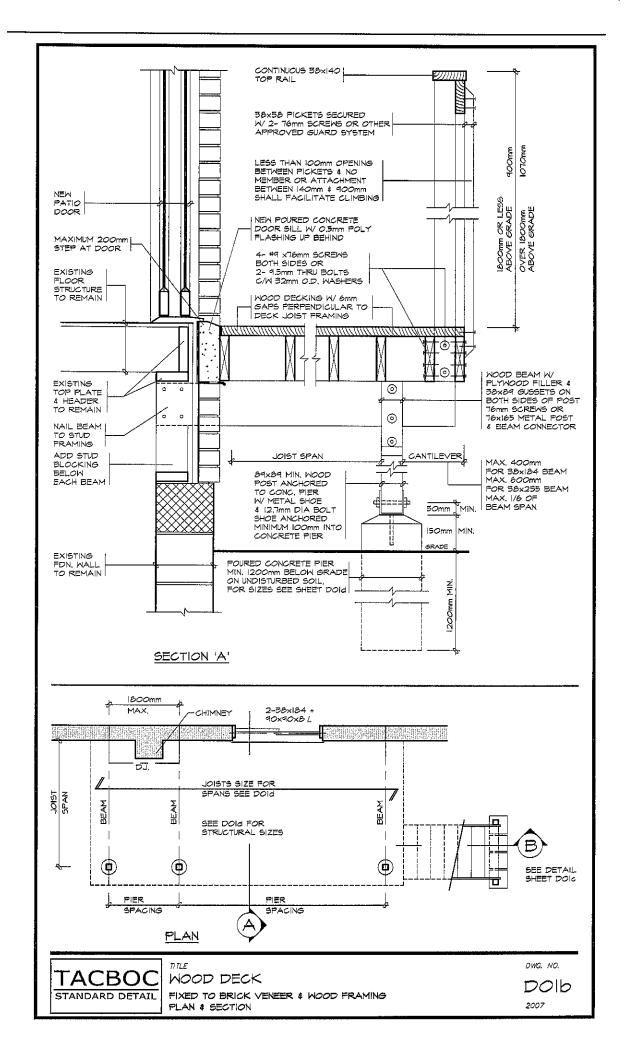

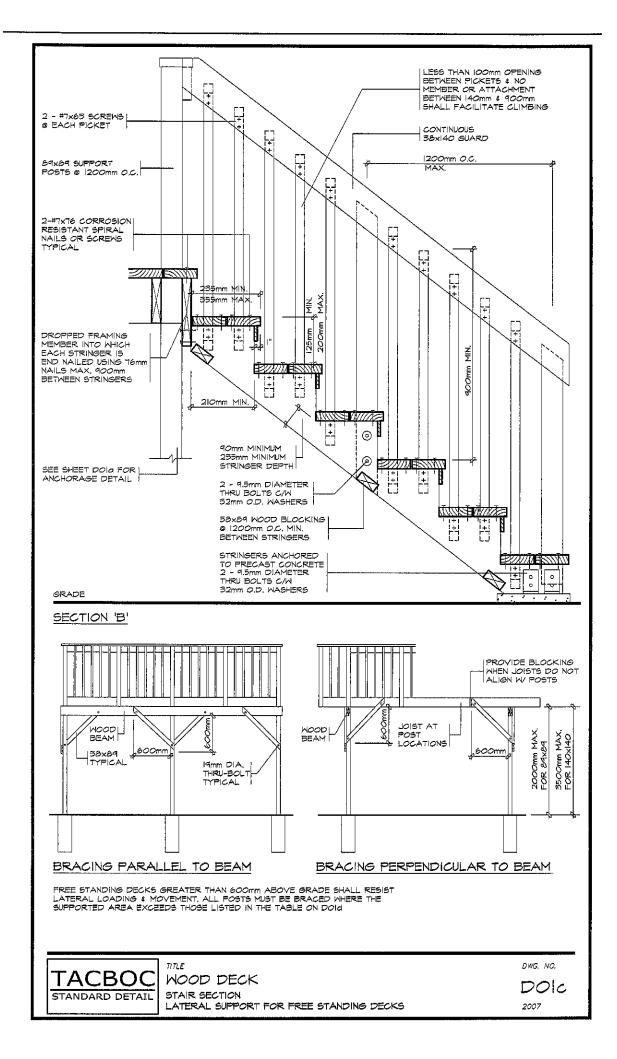

				BEAM S	SIZING TA	<b>BLE</b>				
SUPPORTED SOIST	LIYE	LIVE LOAD (4 kPa			LIVE LOAD 25 kPa			LIVE LOAD 5.0 kPa		
LENSTH	PIEK	SPACING (n	nm)	PIER SPACING (mm)				R SPACING (mm)		
(mm)	2000	3000	4000	2000	5000	4000	2000	3000	4000	
15 <i>00</i>	2/38x140	2/38x184	3/38×255	2/38×140	3/38x184	3/38×235	3/38x140	2/38x255	2/38×286	
2000	2/38x140	3/38x184	3/38x235	2/38x184	2/38x235	3/38×286	2/38xi84	2/38×255	3/38×286	
2500	2/38xl84	2/58×255	3/38x286	2/38xl84	3/38x235	3/38x286	2/38xl84	3/38×235	4/38×286	
3000	2/38x 84	2/38×235	3/38x286	2/38xi84	5/38x235	4/38x286	2/38xi84	3/38x235	4/38×286	
3500	2/38x184	5/58x255	3/38x286	2/38xì84	3/58×255	4/38x286	3/58x184	3/38×286	N/A	
4000	2/38xi84	5/58x235	4/38×286	2/38xl64	3/38×286	N/A	3/38xl84	3/38×286	N/A	


				JOIST :	SIZING T	ABLE				
JOIST	LIVE	LIVE LOAD 1.4 kPa			LIVE LOAD 25 kPa			LIVE LOAD 3.0 kPa		
SPAN	عاص ا	t spacing (	(mm)	JOIST SPACING (mm)			Jols	ST SPACING (mm)		
(mm)	500	400	600	500	400	600	300	400	600	
2000	58xi40	38x140	38x140	38x140	38xi40	58x140	38x140	38x140	58x140	
25 <i>00</i>	38x140	38x140	38x184	38x140	38×140	38x184	38x140	38xl84	38x184	
3000	38x140	58xi84	38x184	38x184	38x184	58×255	58xi84	38xl84	38x235	
35 <i>00</i>	38x184	38x184	38×235	38x184	38x235	38×235	38x235	38x235	38×235	
4000	38×255	38×295	38x286	38x235	58×255	38×286	58x235	58x235	38x286	

FOOTING SIZES					
SOIL BEARING CAPACITIES (kPa)					
SOIL TYPE	BEARING PRESSURE (kPa)				
SOFT CLAY	40				
LOOSE SAND OR GRAVEL	50				
FIRM CLAY	75				
DENSE OR COMPACT SILT	100				
STIFF CLAY	150				
DENSE COMPACT SAND OR GRAVEL	150				
TILL.	200				
CLAY SHALE	300				
50UND ROCK	500				

PIER S	IZES
DIAMETER (mm)	м2
200	0.03
250	0.05
300	0.08
350	0.10
400	0,13
500	0,20
600	0.50

	۲۵	OST SIZIN	NG TABLE				
POST	MAXIMUM	MAX. SUPPORTED DECK AREA (M2)					
SIZE (mm)	HEIGHT (M)	L	VE LOAD (K	<b>්</b> ඛ			
Craity	(1-1/	1,9	2.5	<b>3</b> ,0			
	1,0	10.86	8.71	7.48			
Baxba	1,5	5.43	4.76	4.09			
	2.0	3.15	2.55	2.17			
	20	13.67	IO 8B	g 43			
	2,0 2,5	15.67 9.32	10.98	4.43 6.43			
140x140	<b></b>	13.67 4.32 6.35	10.98 T.48 5.10	4.43 6.43 4.38			

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# GENERAL NOTES

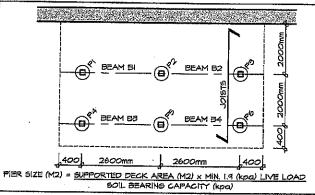- A MINIMUM LIVE LOAD OF 1.9 (kPa) SHALL BE APPLIED IN ALL LOCATIONS.
- 2. THE PRESCRIBED SNOW LOAD FOR 225 SELECTED ONTARIO LOCATIONS IS INDICATED IN COLUMN 12 OF TABLE 1.2 IN SUPPLEMENTARY GUIDELINE 50-1 OF THE ONTARIO BUILDING CODE. THE ONN LOAD SHALL SE APPLIED AS THE MINIMM LIVE LOAD WHERE IT IS GREATER THAN 1.4 (RPG)
- 3. A SITE PLAN OR SURVEY IS REQUIRED SHOWING ALL LOT LINES & DIMENSIONS, SIZE & LOCATION OF ALL EXISTING BUILDINGS & DECKS.
- 4. LIMBER NO. 2 SPF OR BETTER WOOD POSTS MIN. 84x84 (SOLID), USE CORROSION RESISTANT SPIRAL NAILS OR SCREWS,
- A DECK IS NOT PERMITTED TO BE SUPPORTED ON BRICK VENEER.
   CANTILEVERED JOISTS AND BEAMS ARE LIMITED TO 1/6 THE MEMBERS LENGTH.
- CONCRETE PIERS SHALL BEAR ON UNDISTURBED SOIL. THE BEARING CAPACITY OF THE SOIL SHALL BE DETERMINED PRIOR TO CONSTRUCTION.
- MAXIMIM HEIGHT REFERG TO THE HEIGHT OF THE POST FROM THE TOP OF THE PIER TO THE DECK SURFACE.
- 9. BEAMS WITH MORE THAN 2 MEMBERS MUST BE SUPPORTED BY 140XI40 POSTS.
- IO. THE ALLOWABLE SOIL BEARING PRESSURE SHALL BE REDUCED BY 50% WHILE THE WATER IS AT OR NEAR THE BOTTOM OF THE FOOTING EXCAVATION.
- II. CONTACT YOUR LOCAL BUILDING DEPARTMENT FOR FURTHER INFORMATION ABOUT LOCAL SOIL BEARING CAPACITIES.
- 12. JOISTS SPANNING MORE THAN 2100mm ARE TO HAVE BRIDGING AT LEAST EVERY 2100mm O.C..

TACBOC STANDARD DETAIL

MOOD DECK STRUCTURAL SIZING TABLES

DWG. NO.

Dold

2007